LOCATION MAP

GENERAL NOTES:

VERTICAL DATUM = 88

PID = R04813 - 031 - 007 - 000

3. EXISTING ZONING DISTRICT: CBD

4. LAND CLASSIFICATION: COMMERICAL

. NEW HANOVER COUNTY PARCEL NUMBERS.:

5. THIS SITE IS LOCATED WITHIN ZONE "X" ACCORDING TO FEMA FIRM

8. AS-BUILT, BOUNDARY AND TOPOGRAPHIC SURVEY PERFORMED AND

9. STORMWATER DRAINS TO CAPE FEAR RIVER, SC 18-(71)

PORTLAND, ME 04101

LAND OWNER - 214 RED CROSS STREET LLC

PROVIDED TO CSD ENGINEERING BY PARAMOUNTE ENGINEERING, INC;

188 STATE STREET, 3RD FLOOR

2. TOTAL PROJECT AREA: 4,176 (0.10 AC.)

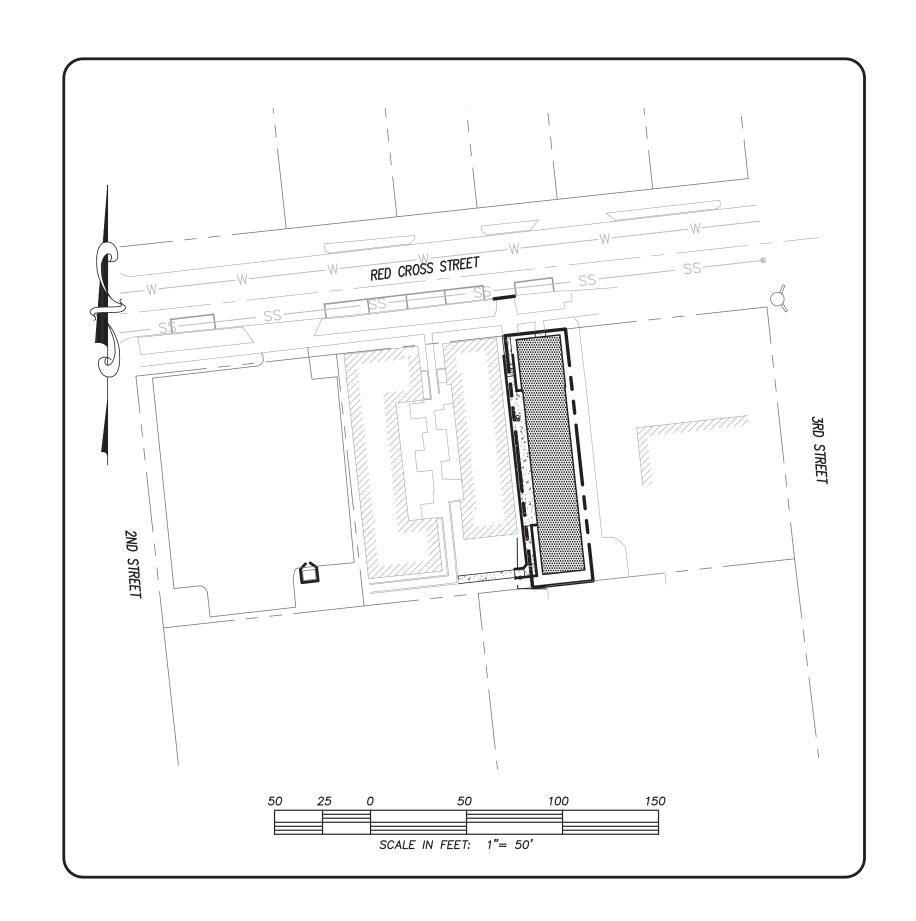
6. SITE ADDRESS: 214 RED CROSS STREET

7. EXISTING IMPERVIOUS ONSITE = 0.0 SF

CONSTRUCTION DRAWINGS for

214 RED CROSS STREET

LOCATED IN CITY OF WILMINGTON NEW HANOVER COUNTY, NORTH CAROLINA



,	INDEX TO DRAWINGS			
SHEET No.	DESCRIPTION	DRAWING No.		
1 OF 6	COVER SHEET CD_COVER			
2 OF 6	SITE PLAN SP2			
3 OF 6	OFFSITE IMPROVEMENTS SP3			
4 OF 6	STORMWATER PLAN SWP			
5 OF 6	GRADING DETAIL GRADING			
6 OF 6	CITY OF WILMINGTON CONSTRUCTION DETAILS SP_DET-1			

LEGEND EXISTING BOUNDARY EXISTING WATERLINE — PROPOSED LOTLINE PROPOSED WATERLINE CENTERLINE OF RIGHT OF WAY CONTOUR LINE & ELEVATION EXISTING / PROPOSED STORM SEWER & CATCH BASIN DRAINAGE FLOW EXIST. IRON PIPE 30' DRAINAGE EASEMENT WATER METER SERVICE CONNECTION EXIST. CONCRETE MONUMENT PROPOSED DRAINAGE PIPE GATE VALVE PROPOSED SANITARY REDUCER (S)——SS ——— SEWER & MANHOLE HANDICAP RAMP EXISTING SANITARY SEWER & MANHOLE

OWNER: 214 RED CROSS STREET LLC 188 STATE STREET, 3RD FLOOR PORTLAND, ME 04101

Public Services Engineering Division APPROVED DRAINAGE PLAN Date: _____Permit #_____

For each open utility cut of City streets, a \$325 permit shall be required from the City prior to occupancy and/or project acceptance.


	Approved Construction Plan
Name _	Date
Planning]
Traffic_	
Fire	

RECEIVED

By Pat O'Mahony at 8:13 am, Dec 16, 2021

NOTES:

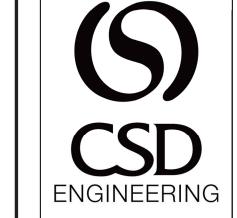- ASBUILT, BOUNDARY AND TOPOGRAPHIC SURVEY PERFORMED AND PROVIDED CSD ENGINEERING BY TO CSD ENGINEERING BY PARAMOUNTE ENGINEERING INC. VERTICAL DATUM = 88
- 2. THIS MAP IS NOT FOR CONVEYANCE, RECORDATION, OR SALES.
- 3. THIS PROPERTY IS LOCATED WITHIN ZONE "X" ACCORDING TO THE FEMA FLOOD INSURANCE RATE MAP,
- 3720311800L, EFFECTIVE DATE 8/28/18 4. EXISTING ZONING: CBD
- 5. CFPUA WATER
- 6. CFPUA SEWER
- 7. ALL CONSTRUCTION TO CONFORM TO NEW HANOVER COUNTY STANDARDS AND APPLICABLE STATE & LOCAL CODES.
- 8. CONTRACTOR TO COORDINATE ANY REQUIRED TRAFFIC CONTROL WITH
- CITY OF WILMINGTON AND OR NCDOT.
- 9. CARE SHALL BE TAKEN DURING FINAL GRADING TO ENSURE POSITIVE DRAINAGE AWAY FROM BUILDINGS AND TO RECEIVING STRUCTURES. ROOF DRAIN DOWNSPOUTS TO BE CONNECTED TO STORM DRAINAGE STUBOUTS OR DIRECTED TO STREET/PARKING AREAS.
- 10. CONTRACTOR IS RESPONSIBLE FOR COORDINATION OF ANY RELOCATIONS, RE-ALIGNMENTS, DISCONNECTIONS OR CONNECTIONS OF EXISTING UTILITIES WITH APPLICABLE AUTHORITIES.
- 11. CLEARING AND GRUBBING OF SITE TO INCLUDE REMOVAL OF EXISTING CURB, ASPHALT, INLETS, AND ANY OTHER STRUCTURES INCLUDING TREES, STUMPS AND DEBRIS EXISTING ON SITE. TREES NOT REQUIRED TO BE CLEARED FOR CONSTRUCTION SHALL REMAIN UNLESS OTHERWISE DIRECTED
- 12. INFORMATION CONCERNING UNDERGROUND UTILITIES WAS OBTAINED FROM AVAILABLE RECORDS. IT SHALL BE THE RESPONSIBILITY OF THE CONTRACTOR TO DETERMINE THE EXACT ELEVATIONS AND LOCATIONS OF ALL EXISTING UTILITIES AT ALL CROSSINGS PRIOR TO COMMENCING TRENCH EXCAVATION. IF ACTUAL CLEARANCES ARE LESS THAN INDICATED ON PLAN, THE CONTRACTOR SHALL CONTACT THE DESIGN ENGINEER BEFORE PROCEEDING WITH CONSTRUCTION. ANY CONDITION DISCOVERED OR EXISTING THAT WOULD NECESSITATE A MODIFICATION OF THESE PLANS SHALL BE BROUGHT TO THE ATTENTION OF THE DESIGN ENGINEER BEFORE PROCEEDING WITH CONSTRUCTION.
- 13. NO CONSTRUCTION IS TO BEGIN BEFORE LOCATION OF EXISTING UTILITIES HAS BEEN DETERMINED. CALL "NC ONE—CALL" AT LEAST 72 HOURS BEFORE COMMENCING CONSTRUCTION.
- 14. CONTRACTOR SHALL ADJUST ALL MANHOLES, VALVE & CURB BOXES TO FINAL GRADE UPON COMPLETION OF ALL CONSTRUCTION. ANY BOXES DAMAGED OR OTHERWISE DISTURBED BY THE CONTRACTOR SHALL BE REPAIRED AT THE EXPENSE OF THE CONTRACTOR.
- 15. THE CONTRACTOR IS RESPONSIBLE FOR CONTROLLING DUST AND EROSION DURING CONSTRUCTION AT HIS EXPENSE. PARKING AREAS SHALL BE
- WATERED TO CONTROL DUST WHEN ORDERED BY THE ENGINEER. 16. NO GEOTECHNICAL TESTING HAS BEEN PERFORMED ON SITE. NO WARRANTY IS MADE FOR SUITABILITY OF SUBGRADE, AND UNDERCUT AND ANY REQUIRED REPLACEMENT WITH SUITABLE MATERIAL SHALL BE THE RESPONSIBILITY OF THE CONTRACTOR.
- 17. CONTRACTOR TO ENSURE THAT PAVEMENT IS PLACED SO AS TO DRAIN POSITIVELY TO THE STREET INLETS AND CATCH BASINS. ALL FUTURE ROOF
- DRAIN DOWNSPOUTS TO BE DIRECTED TO THE STORM DRAINAGE STUBOUTS. 18. CONTRACTOR IS RESPONSIBLE FOR OBTAINING ALL REQUIRED PERMITS.
- 19. THIS PLAN IS FOR SITE GRADING, UTILITIES, SITING, AND DRAINAGE ONLY. SEE BUILDING PLANS FOR DETAILED HOOKUPS TO BUILDINGS, ETC.
- 20. CONTRACTOR AND BUILDER ARE RESPONSIBLE FOR COORDINATING FINISHED FLOOR ELEVATION OF ALL BUILDINGS WITH THE OWNER. ELEVATIONS GIVEN ARE MINIMUM GROUND ELEVATIONS AT THE BUILDING SITE AND DO NOT PURPORT TO BE FINISHED FLOOR. MINIMUM RECOMMENDED FF ELEVATIONS SHOWN ON PLANS.
- 21. AFFECTED NON-MUNICIPAL UTILITIES SHALL BE CONTACTED AND PROVIDED WITH PLANS AND OTHER PERTINENT INFORMATION, WHEN FEASIBLE, TO
- COORDINATE APPROPRIATE SCHEDULING AND PLACEMENT. 22. EXTREME CARE SHALL BE TAKEN TO ENSURE MINIMUM SEPARATIONS AT ALL UTILITY CROSSINGS.
- 23. MINIMUM SEPARATION SHALL BE MAINTAINED AS FOLLOWS: a. HORIZONTAL SEPARATION OF 10 FEET BETWEEN SANITARY SEWER AND WATER MAINS AND STORM SEWER.
 - b. WHERE VERTICAL CLEARANCE IS LESS THAN 24" BETWEEN SANITARY SEWER AND WATER OR WHERE SEWER LINE CROSSES ABOVE WATER MAIN, BOTH PIPES SHALL BE DUCTILE IRON PIPE FOR A MINIMUM OF 10' EITHER SIDE OF CROSSING.
 - c. WHERE VERTICAL CLEARANCE IS LESS THAN 24" BETWEEN SANITARY SEWER AND STORM DRAIN, SANITARY SEWER SHALL BE DUCTILE IRON PIPE FOR A MINIMUM OF 10 FEET EITHER SIDE OF CROSSING.
- d. WHERE VERTICAL CLEARANCE IS LESS THAN 12" BETWEEN SANITARY SEWER AND STORM DRAIN, SANITARY SEWER SHALL BE DUCTILE IRON PIPE FOR A MINIMUM OF 10' EITHER SIDE OF CROSSING, AND BRIDGING SHALL BE INSTALLED PER APPLICABLE UTILITY AUTHORITY'S DETAILS.
- e. IN NO CASE SHALL THERE BE LESS THAN 18" OF SEPARATION BETWEEN OUTSIDE OF WATER MAIN AND OUTSIDE OF SEWER OR STORM DRAINAGE.
- f. MINIMUM COVER OF 36" SHALL BE PROVIDED FOR ALL BURIED WATER MAINS AND SANITARY SEWER MAINS.
- 24. SEE DETAIL SHEETS FOR TYPICAL UTILITIES HOOKUPS.
- 25. ALL SANITARY SEWER MAINS TO BE 8" UNLESS OTHERWISE INDICATED.
- 26. ALL WATER MAINS TO BE 8" UNLESS OTHERWISE INDICATED.
- 27. TWO VALVES ARE REQUIRED AT "T" INTERSECTIONS AND ONE VALVE ON THE WATER LINE TO FIRE HYDRANTS.
- 28. A BLOW-OFF VALVE IS REQUIRED AT THE TERMINUS OF ALL "DEAD END"



LICENSE # C-2710 **ENGINEERING** LAND PLANNING COMMERCIAL / RESIDENTIAL

> P.O. BOX 4041 WILMINGTON, NC 28406 (910) 791–4441

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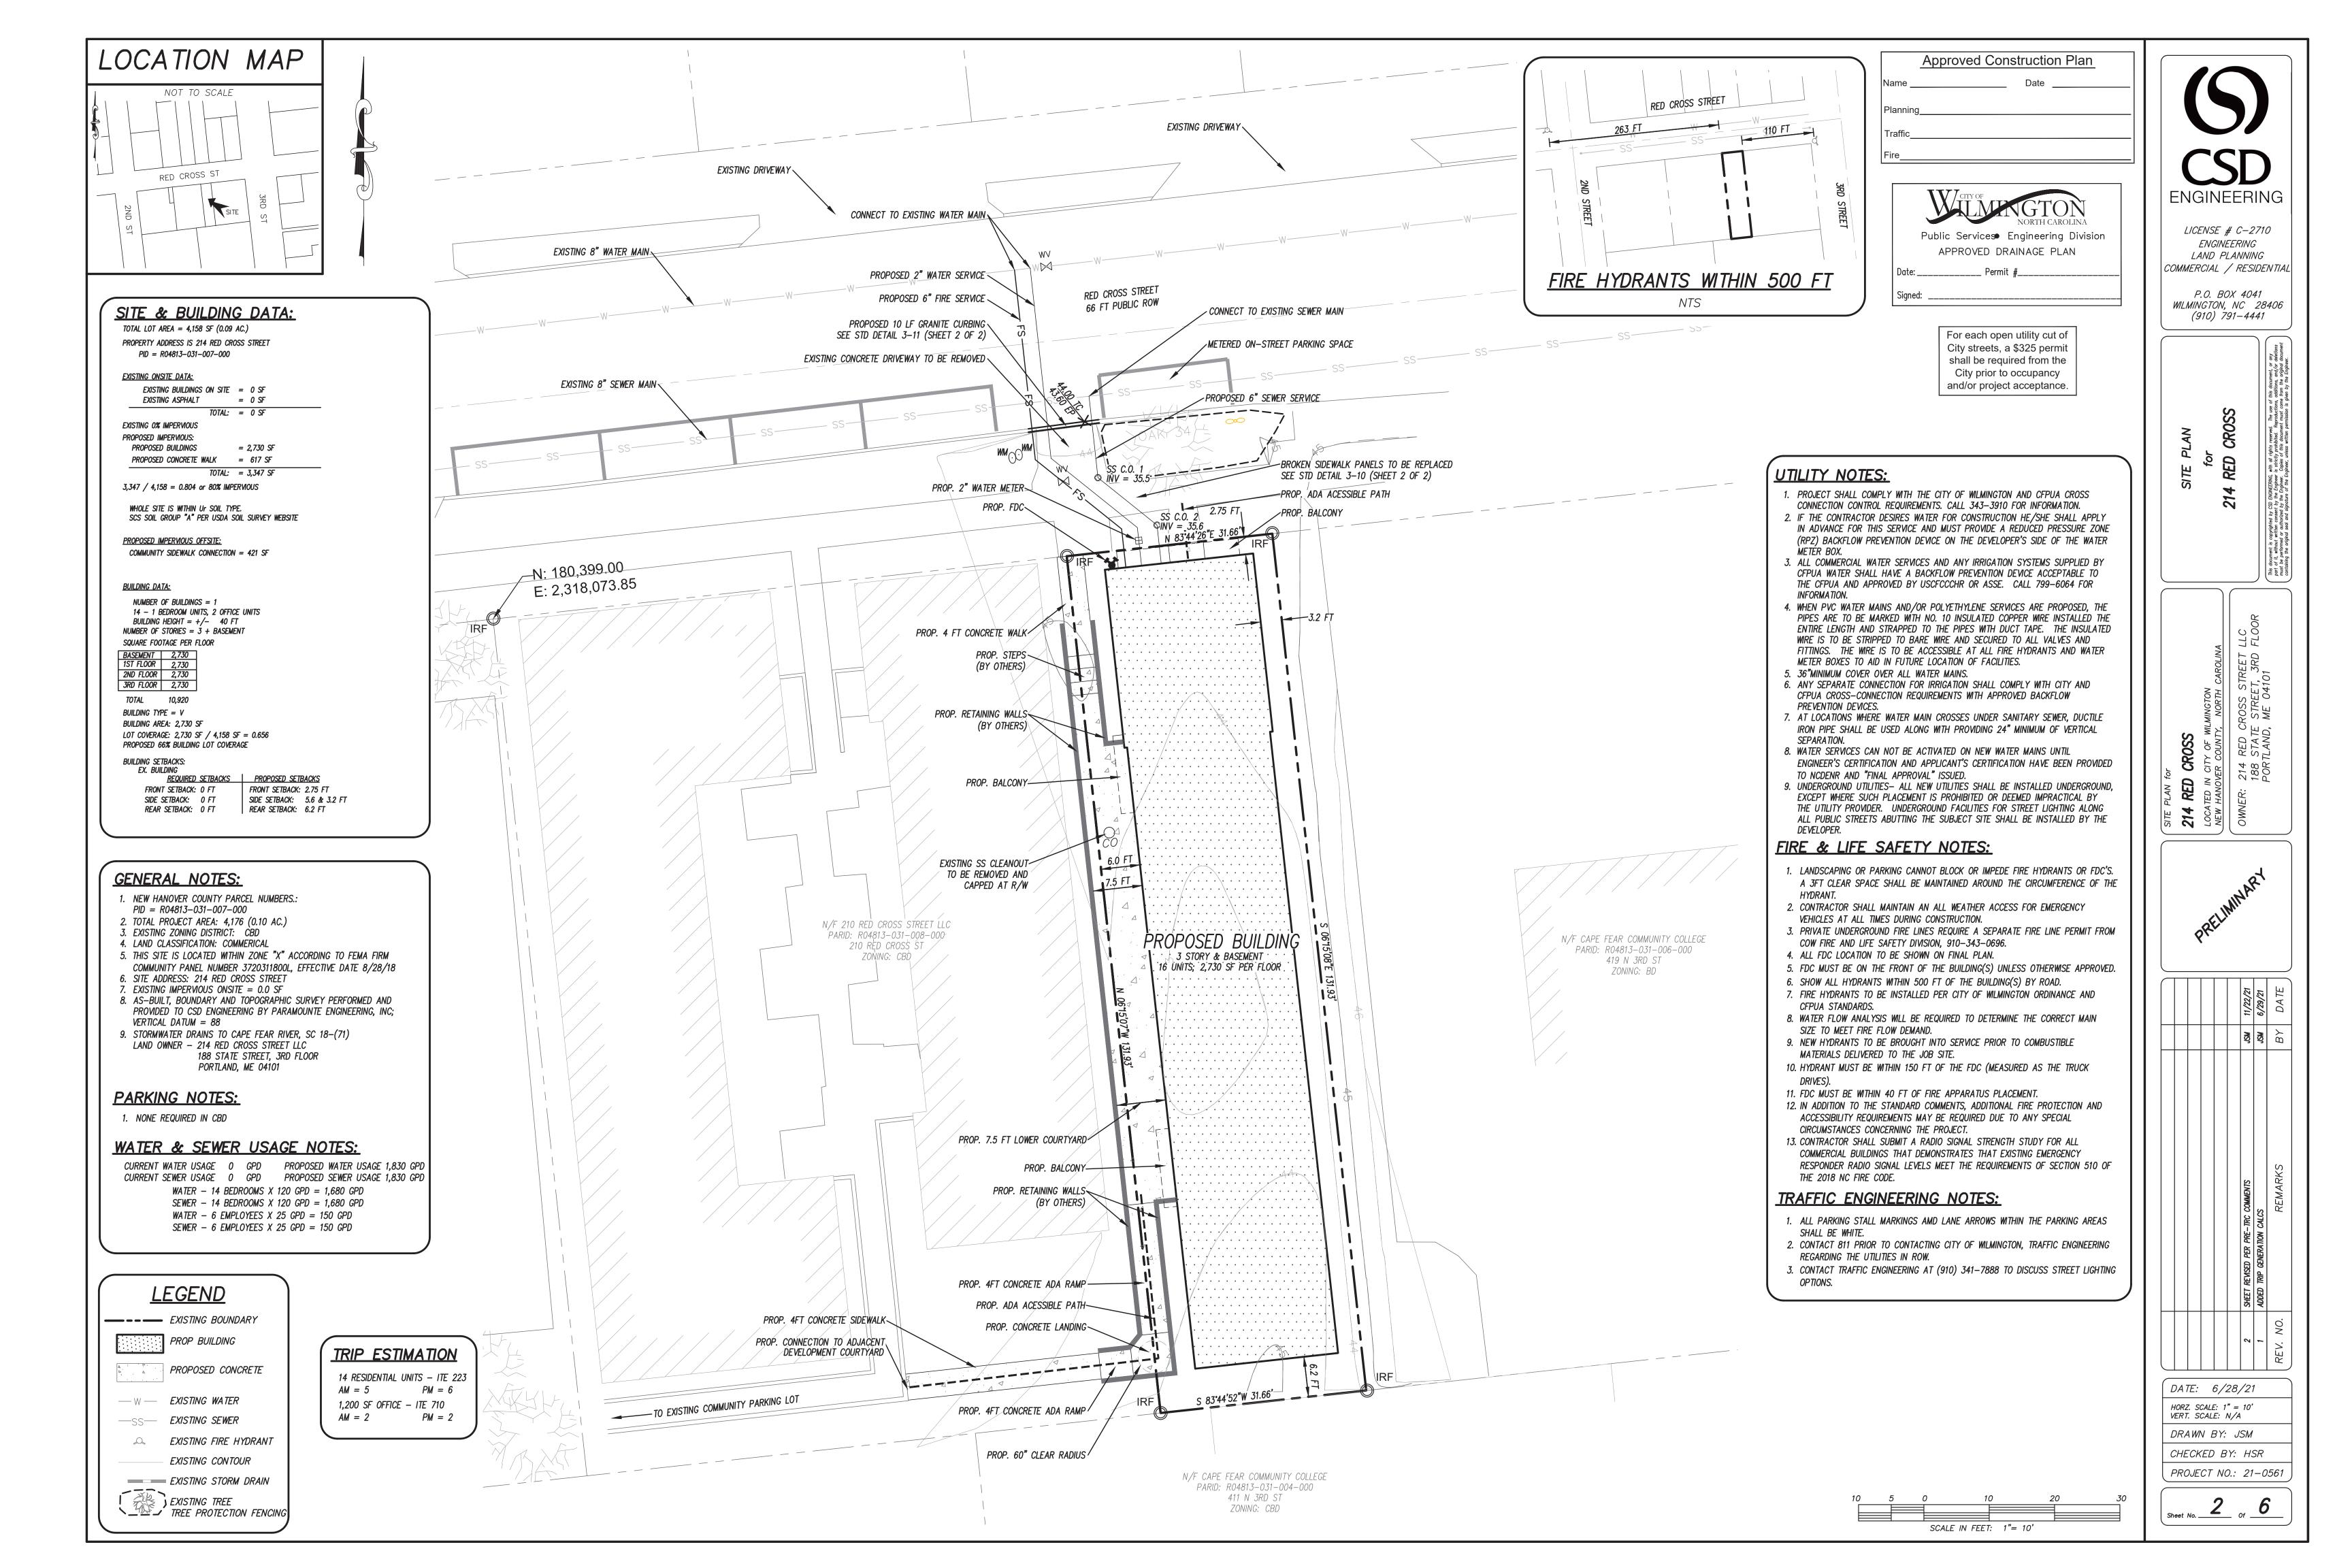
						BY DAT	
						ВУ	
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DATE: 11/22/21							


HORZ. SCALE: 1" = 50' VERT. SCALE: N/A


DRAWN BY: JSM CHECKED BY: HSR


PROJECT NO.: 21-0561

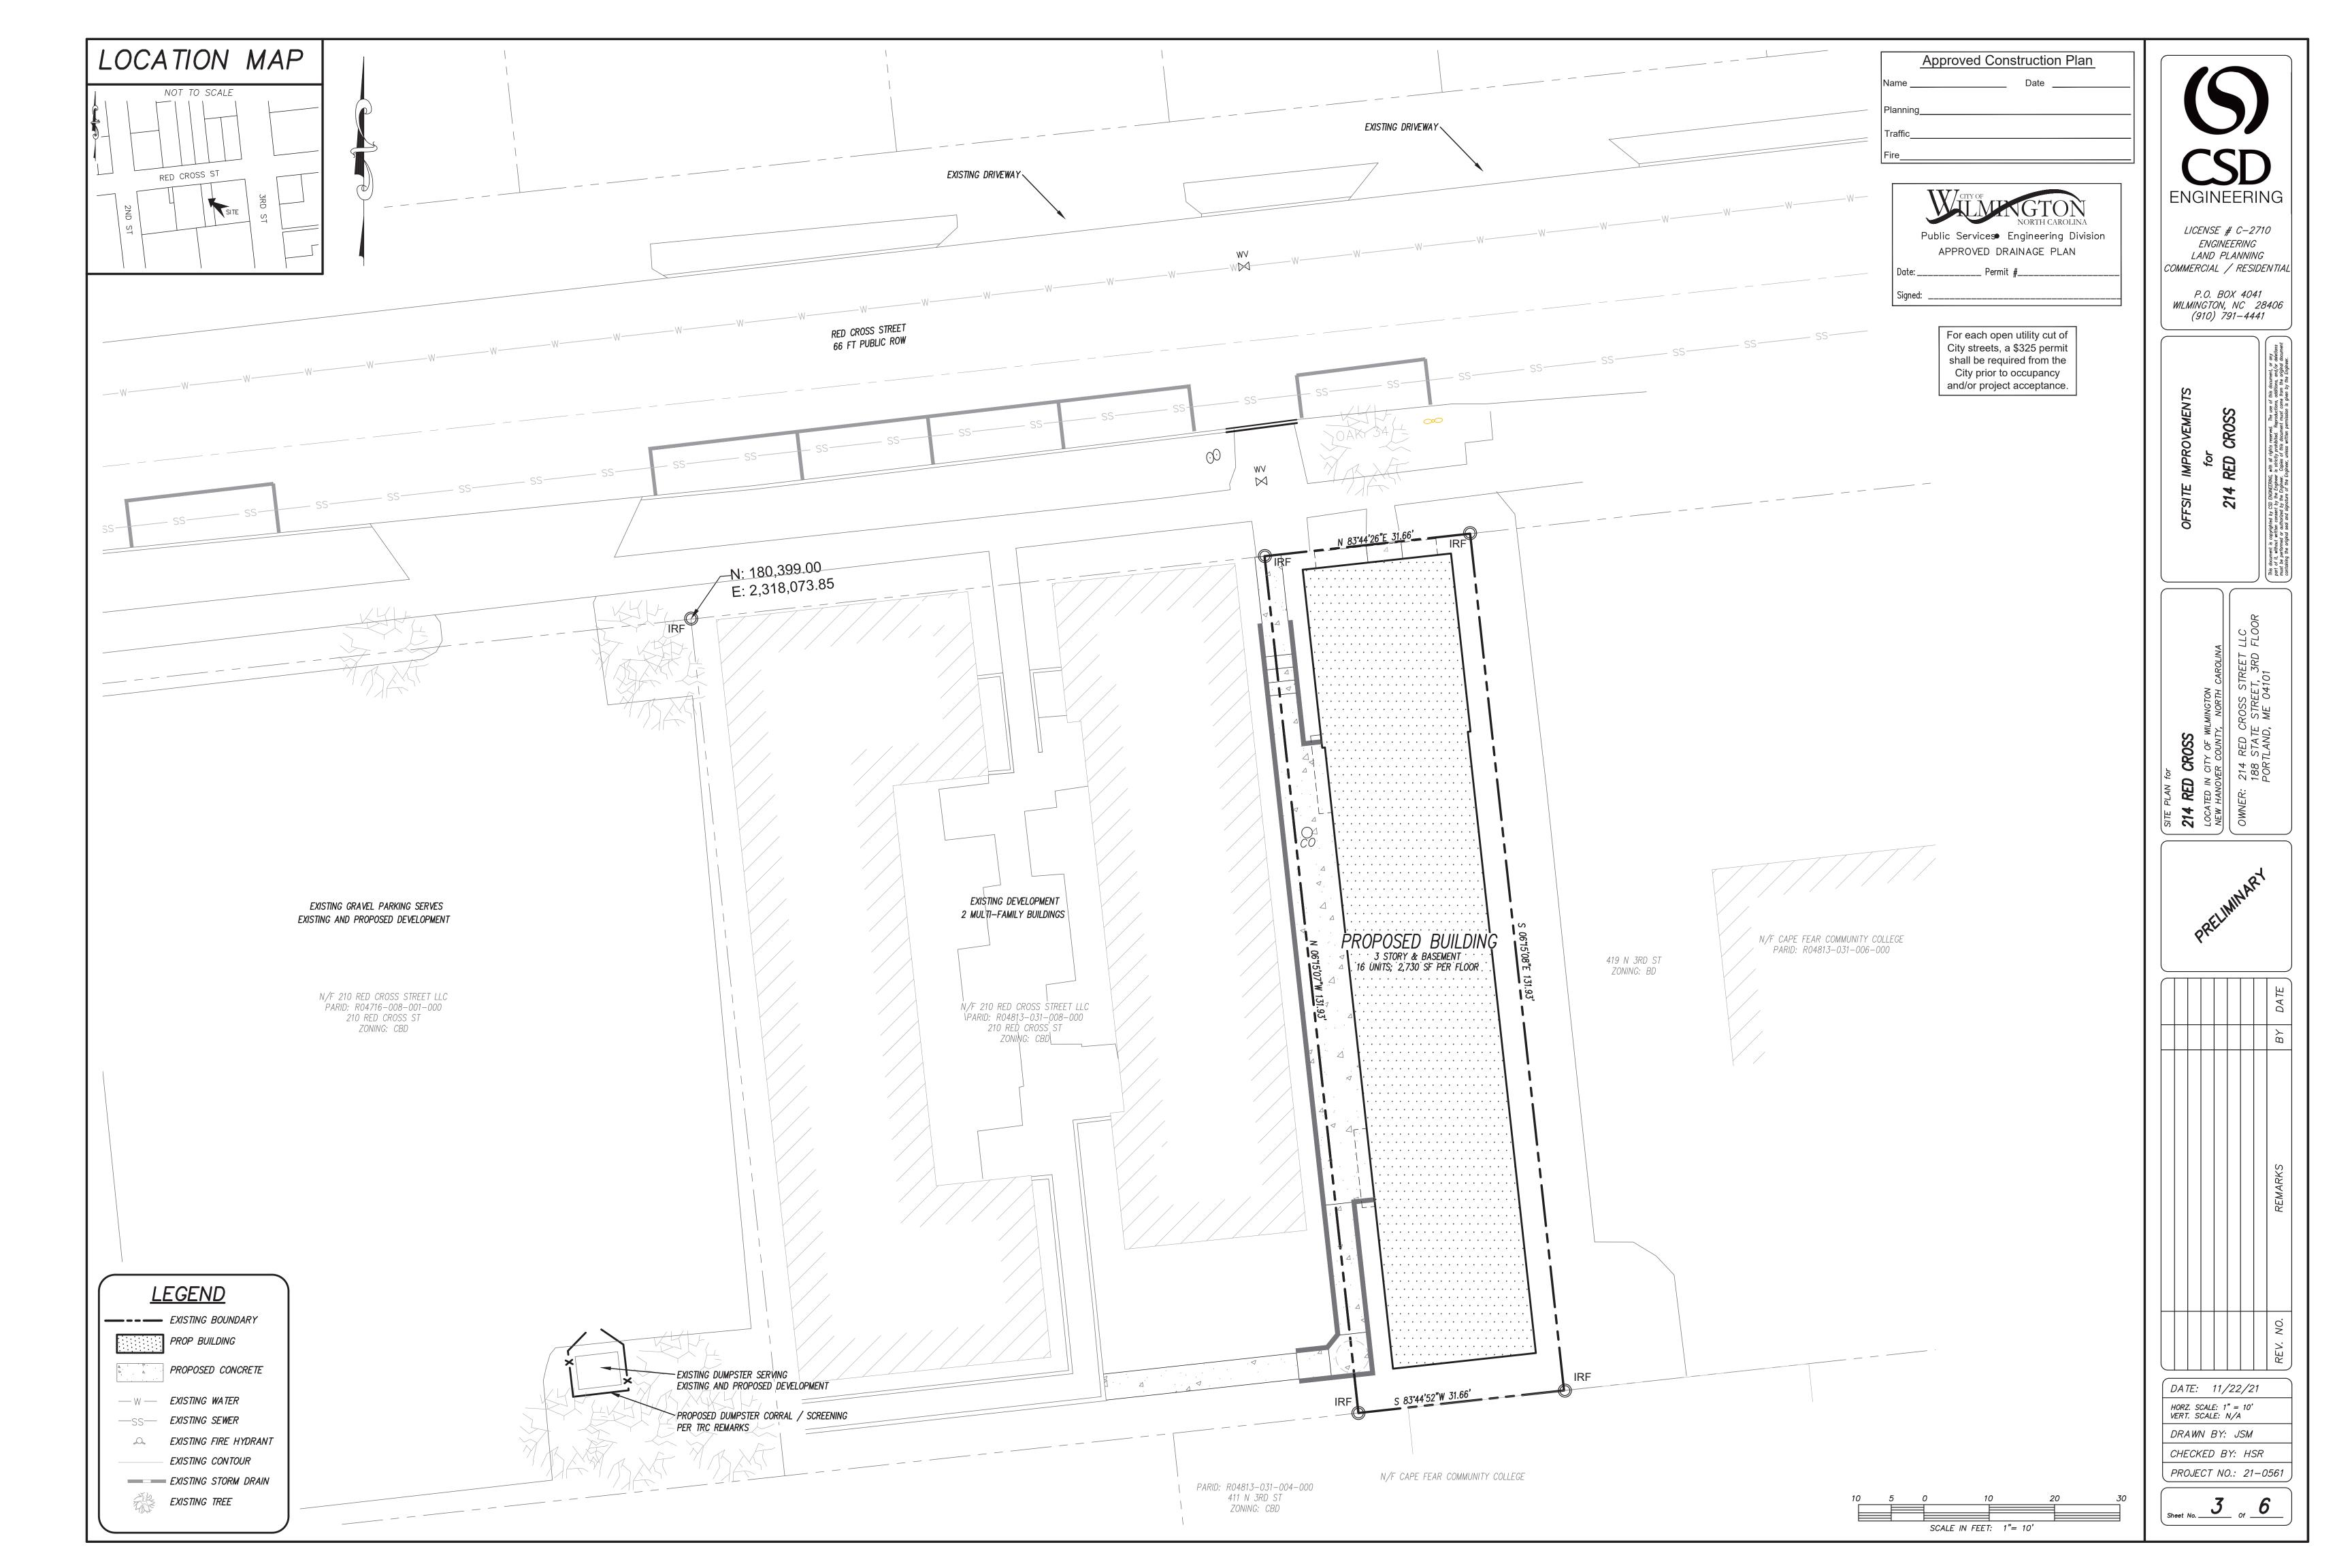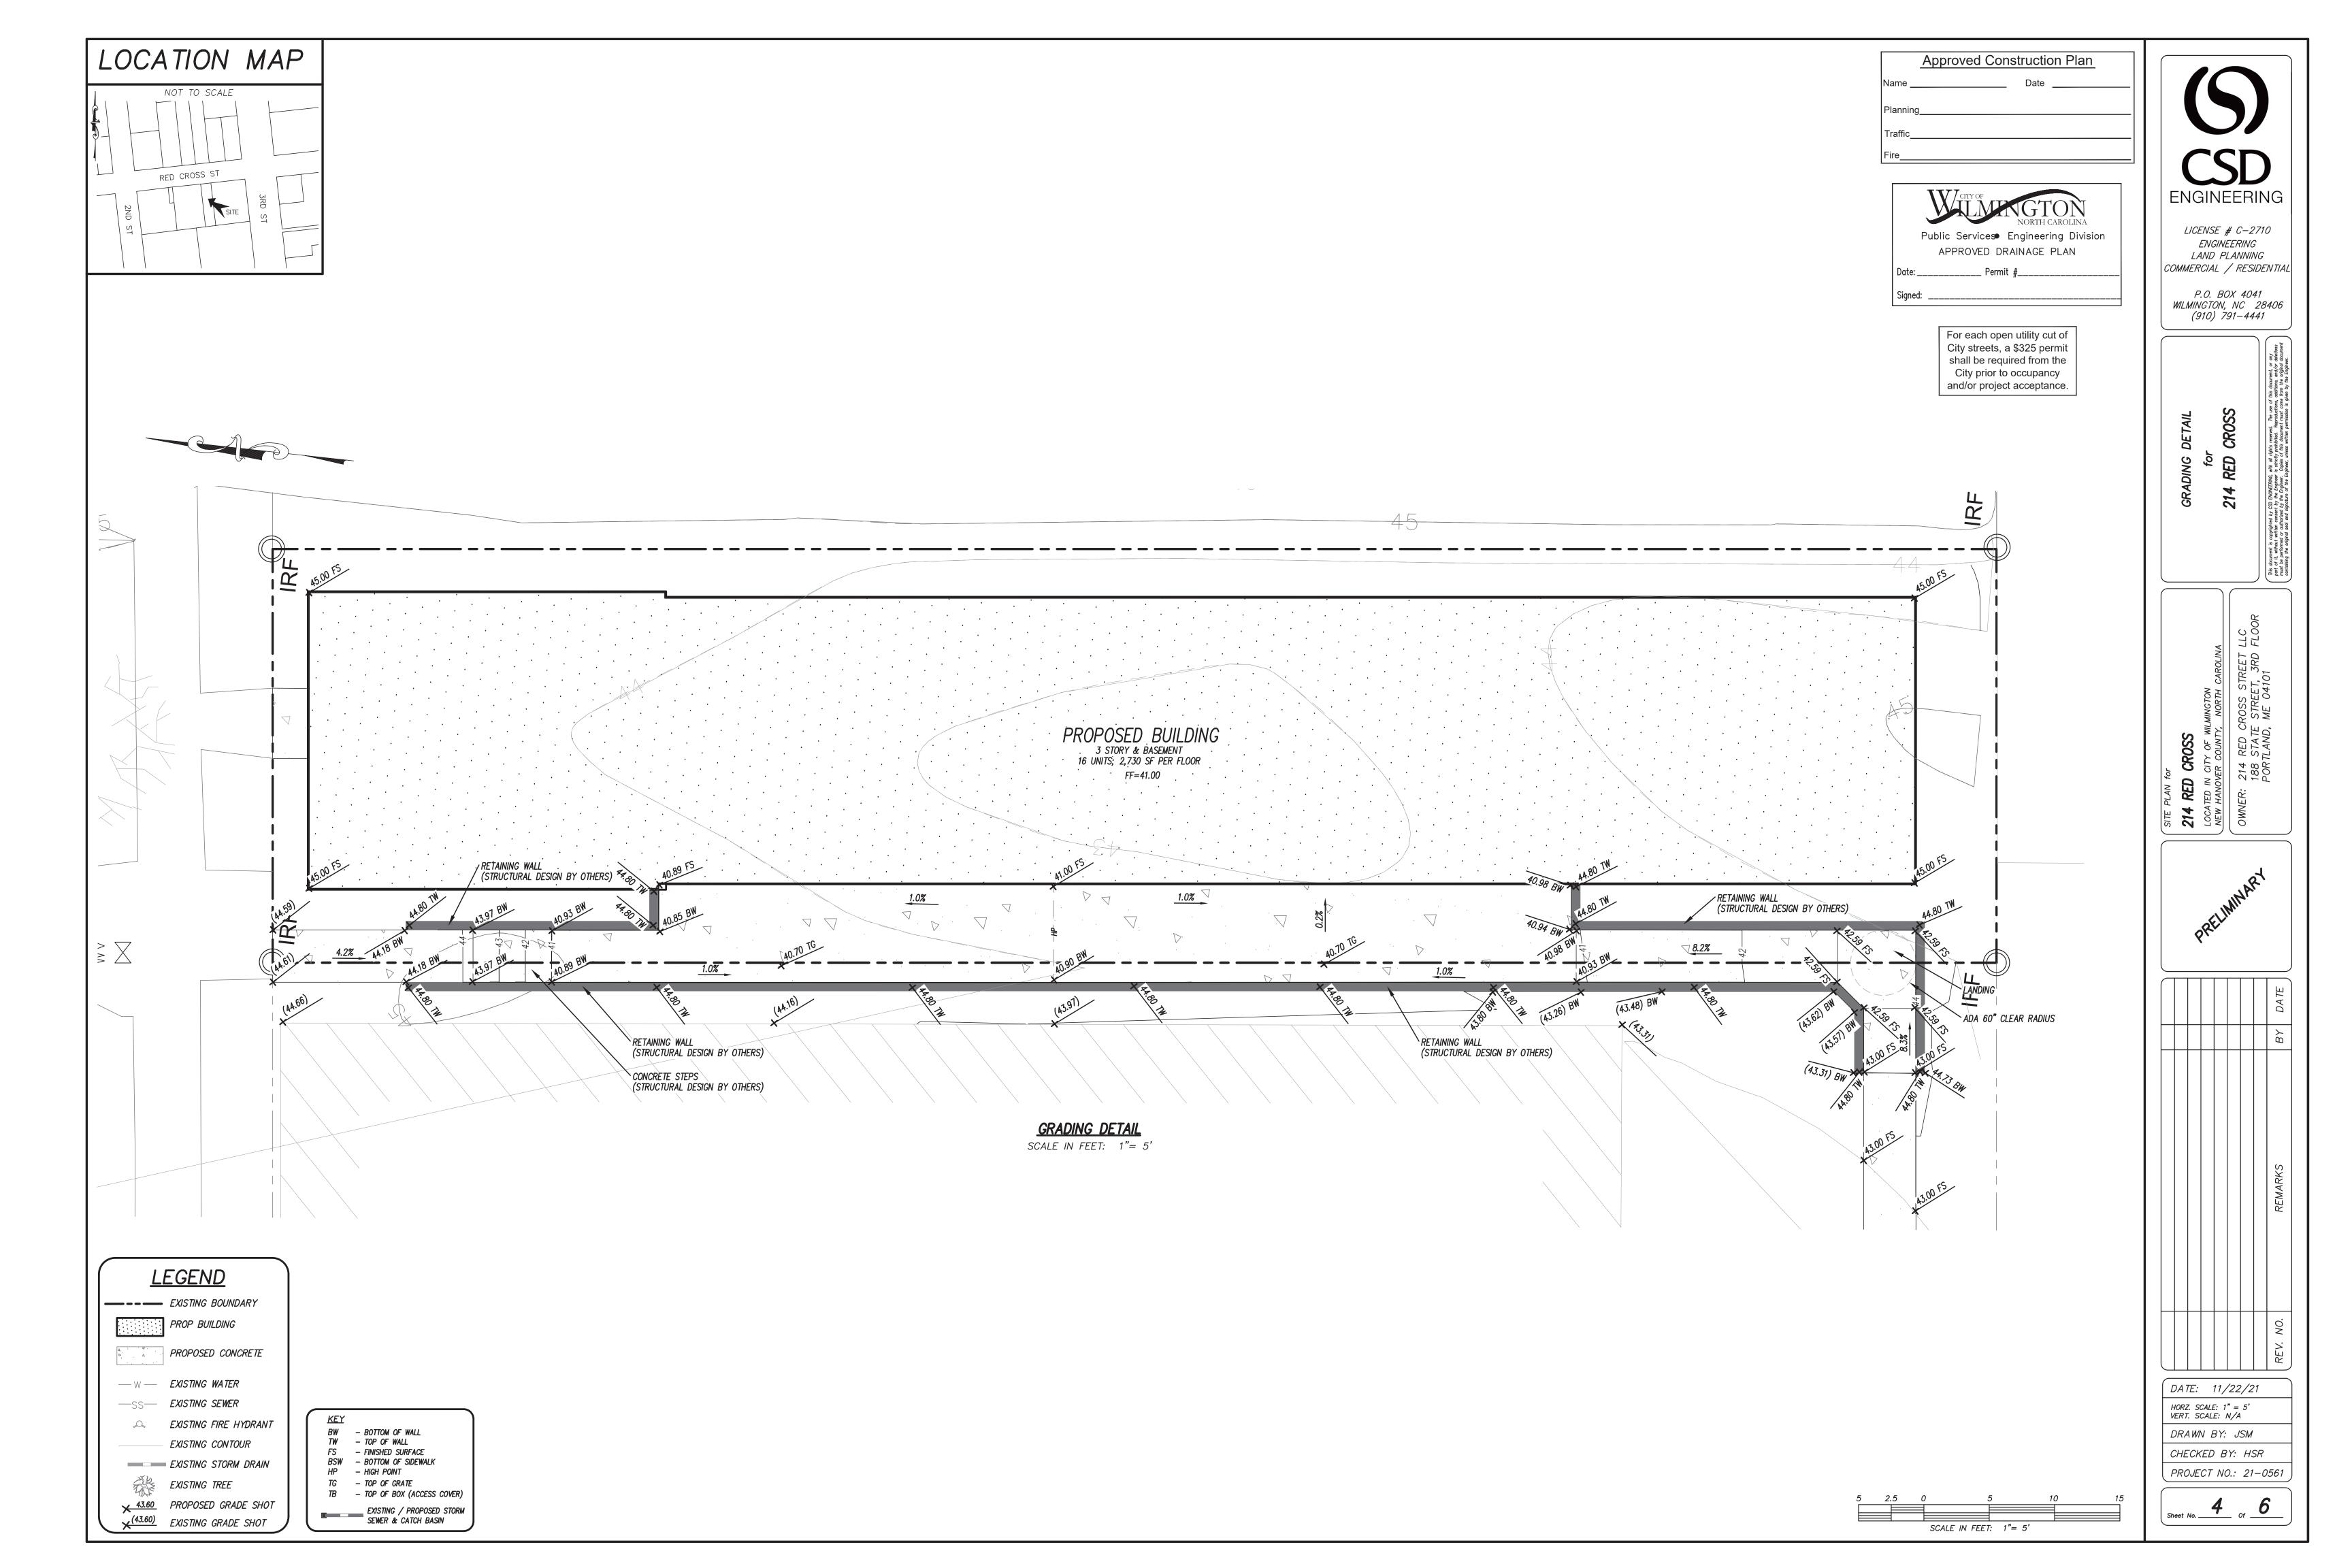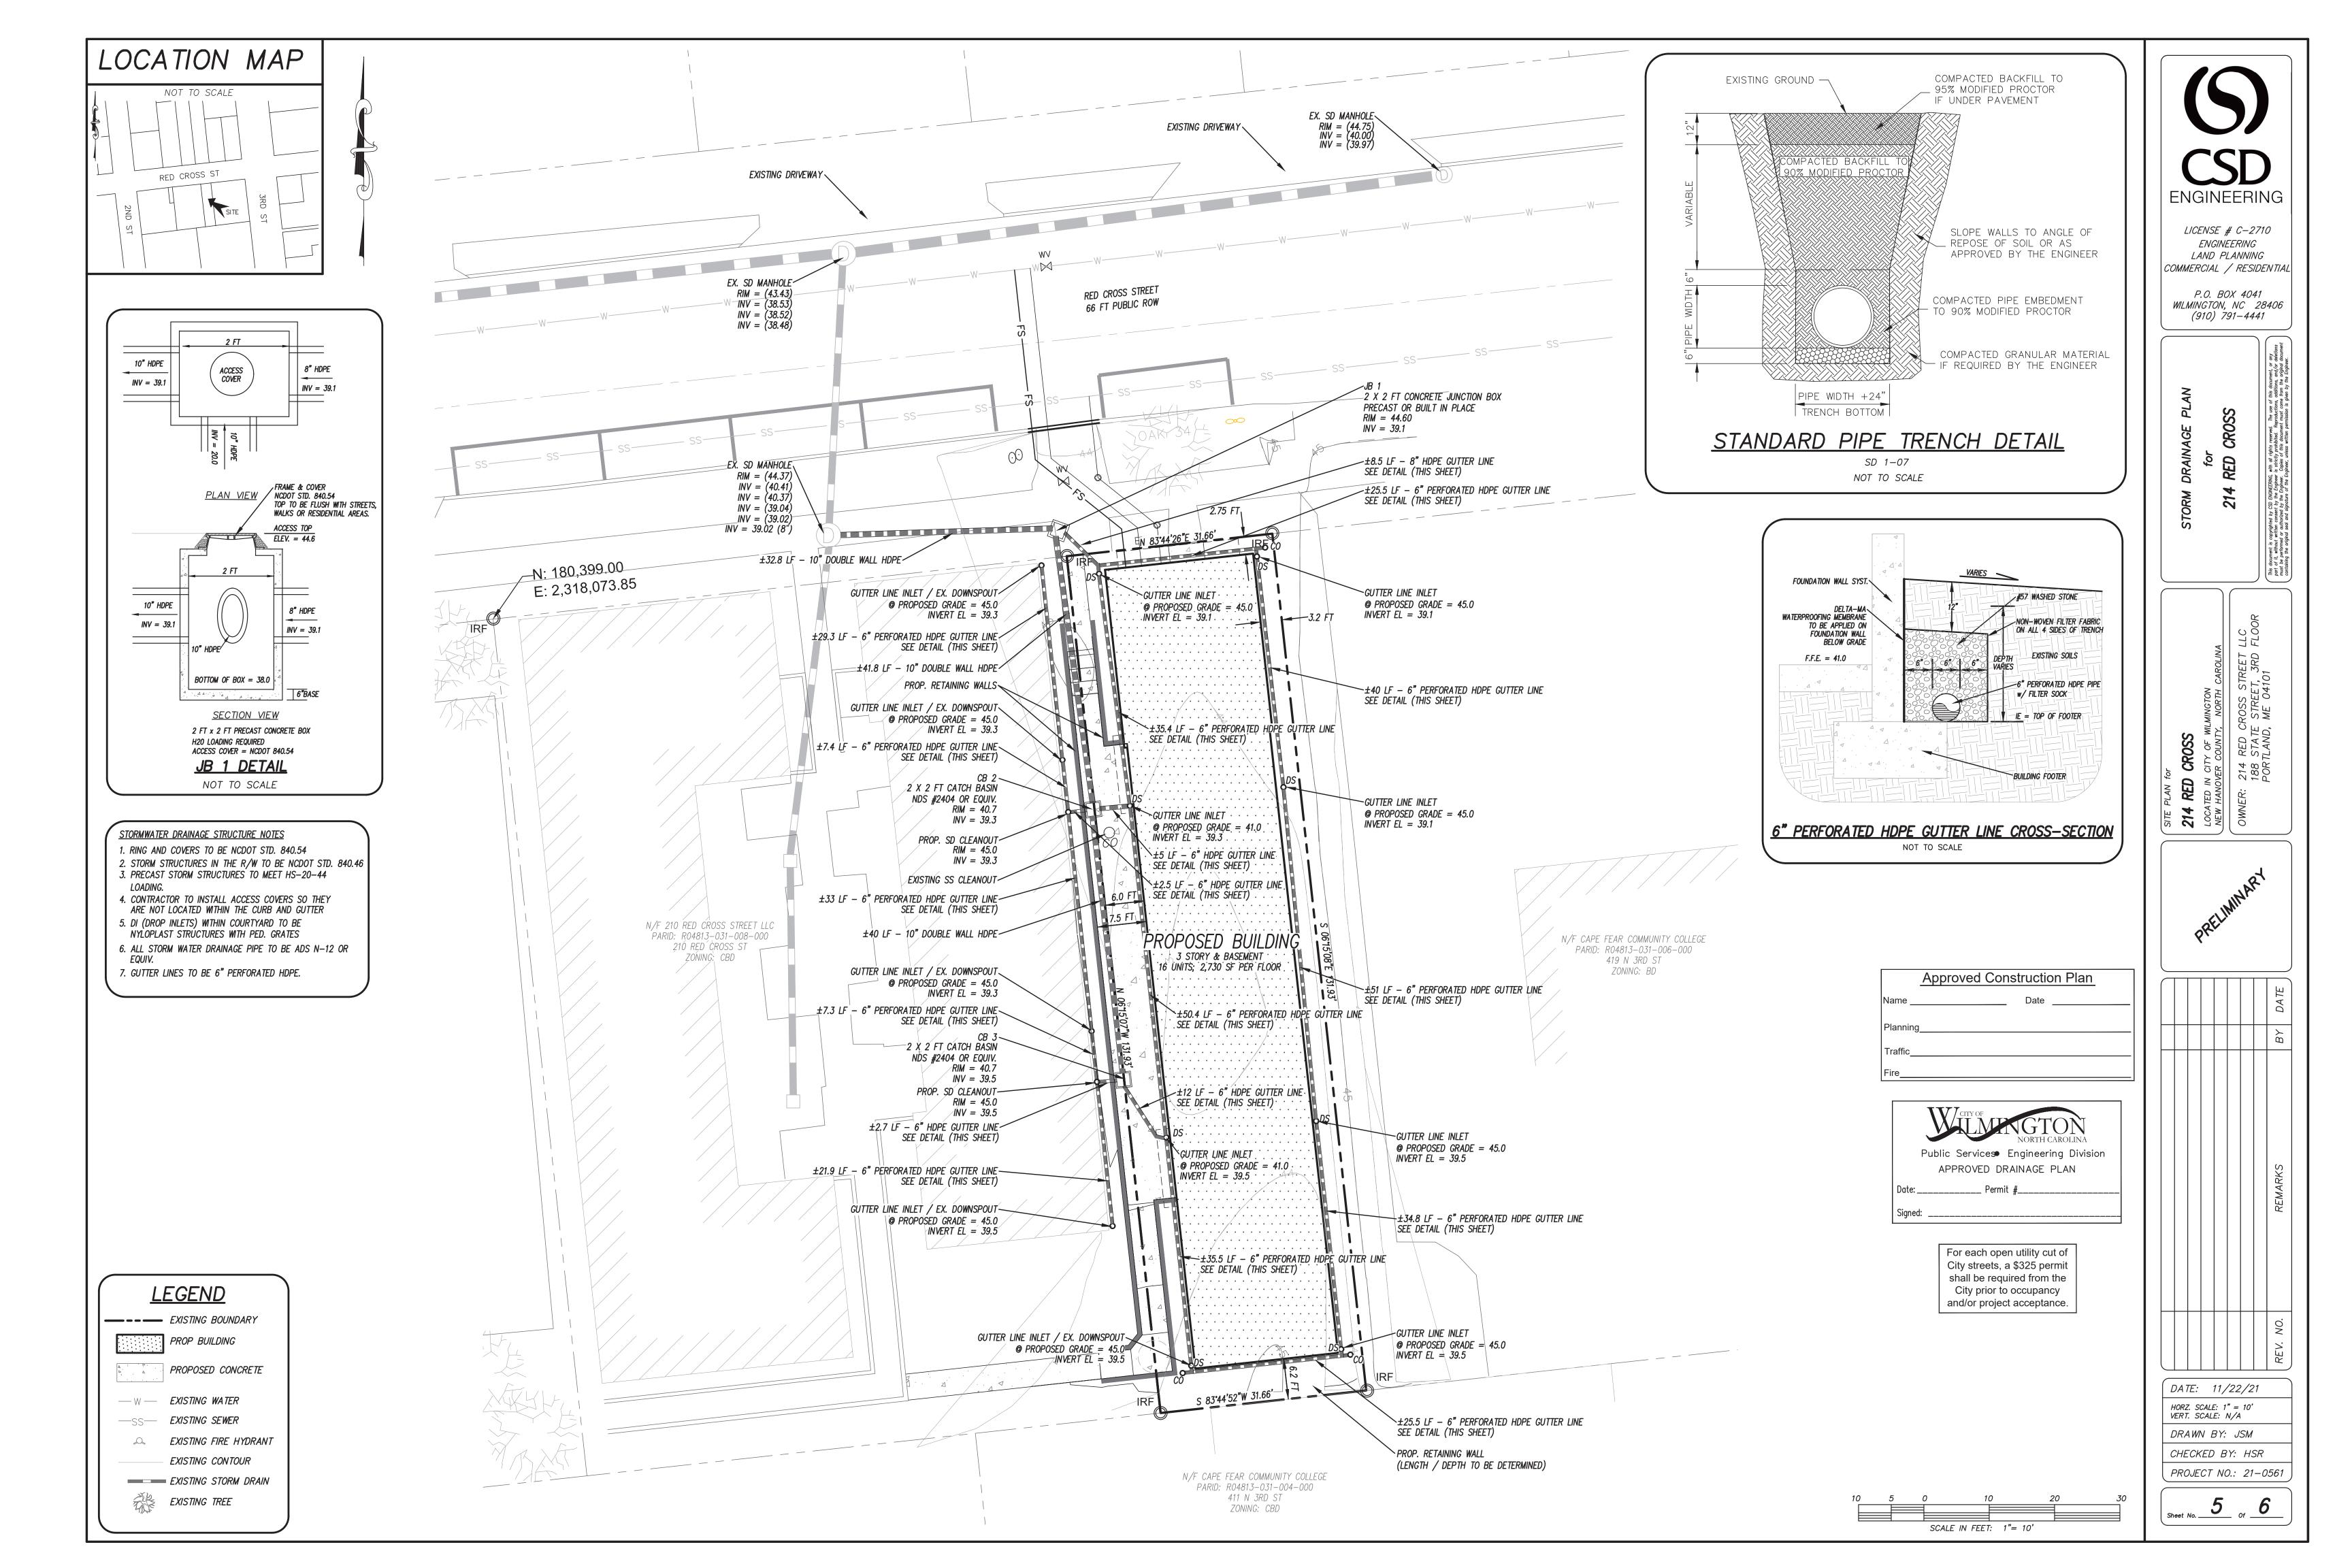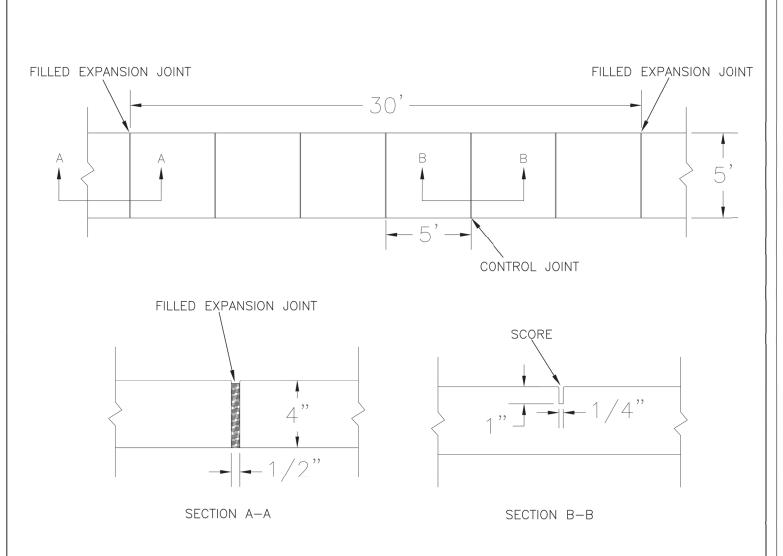
Sheet No. ___1 __ of __6












NOTES: 1. JOINT MATERIAL TO COMPLY WITH CURRENT NCDOT STANDARDS.


- 2. SANITARY SEWER CLEAN-OUTS, WATER METERS, MANHOLES, AND VALVE LIDS TO BE LOCATED OUTSIDE SIDEWALK WHERE FEASIBLE.
- 3. MINIMUM SIDEWALK WIDTH TO BE 6' MINIMUM IF PLACED AT BACK OF CURB.
- 4. CONCRETE FOR ALL SIDEWALKS (EXCEPT ANY PORTION CONTAIN WITHIN A DRIVEWAY
- APRON) SHALL BE CLASS "A" 3,000 PSI.
- 5. MINIMUM REPLACEMENT FOR REPAIRS IS A 5' X 5' PANEL 6. 4" STONE BASE MAY BE REQUIRED FOR POOR SOIL CONDITIONS
- 7. MINIMUM DEPTH FOR TUNNELING BELOW SIDEWALK IS 12"
- 8. MAX ADJACENT GROUND SLOPE WITHOUT RAILING IS 2:1

9. MIN GRADE FOR PROPER DRAINAGE IS 1% IN AT LEAST 1 DIRECTION. MAX CROSS SLOPE IS 2%. MAX LONGITUDINAL SLOPE IS 8.3%, 10% IF LIMITED BY EXISTING CONDITIONS, OR NO GREATER THAN

	OPE OF THE EXISTING ADJACENT ROAD.			
	STANDARD DETAIL	TT//CITY OF		
DATE: OCTOBER, 2010		CITY OF WILMINGTON ENGINEERING		
DRAWN: PB/JSR				
CHECKED: DEC	SIDEWALK	PO BOX 1810 WILMINGTON N.C. 2840		
SCALE NOT TO SCALE		(910) 341–7807	SD 3-10	
		•		

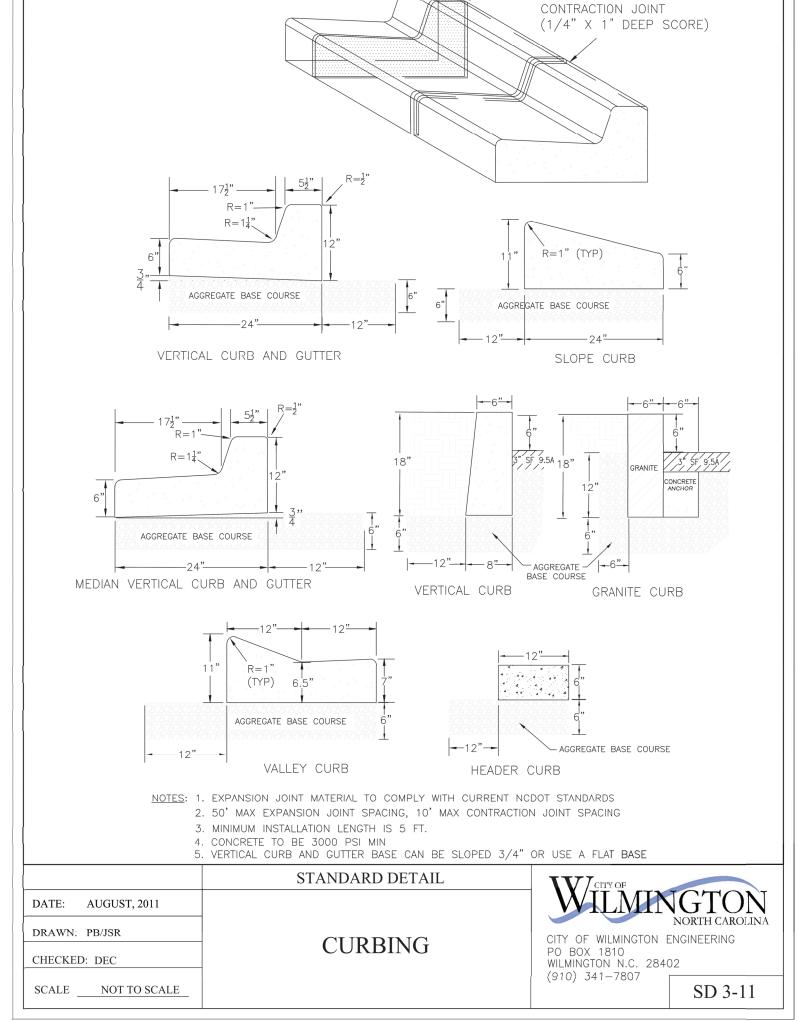

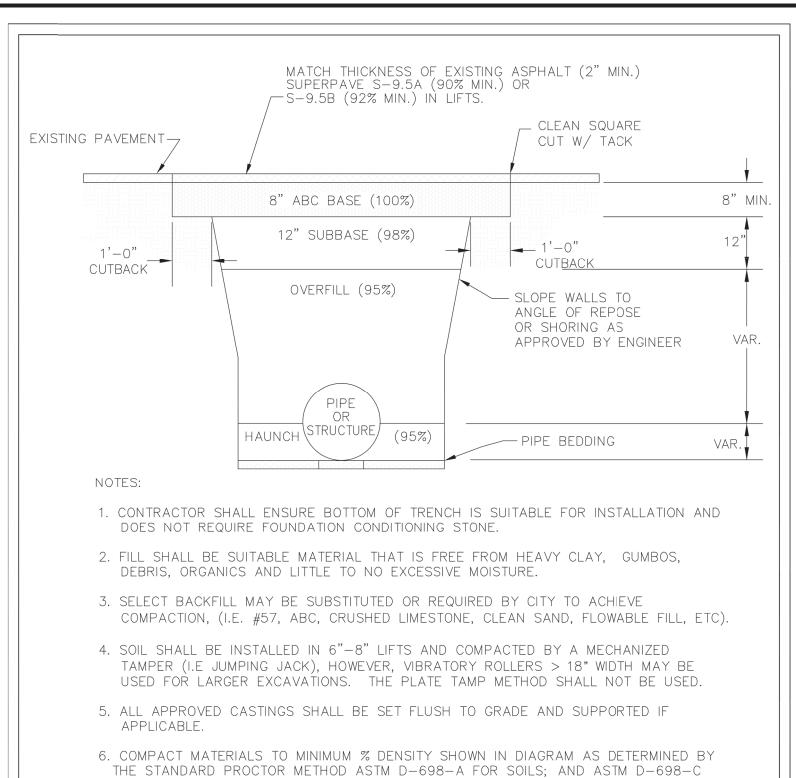OBLIQUE VIEW VERTICAL CURB AND GUTTER 1/2" FILLED EXPANSION JOINT



FOR ABC STONE; AND BY NUCLEAR GAUGE OR CORE SAMPLE FOR ASPHALT.

7. CUTBACKS OF ASPHALT SHALL BE PREPARED ON EDGE OF EXCAVATION OVER TOP OF


	STANDARD DETAIL
DATE: MAY, 2013	DAMENT DEDAIDS
DRAWN BY JSR	PAVEMENT REPAIRS-
CHECKED BY D.E.C., P.E.	UTILITY CUTS

UNDISTURBED SOIL.

SCALE NOT TO SCALE


CITY OF WILMINGTON

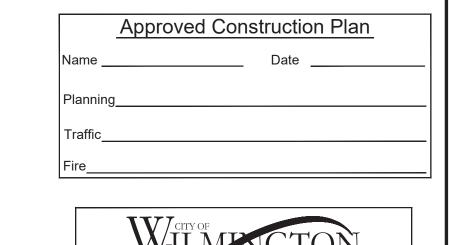ENGINEERING OFFICE 212 OPERATIONS CENTER DRIVE WILMINGTON N.C. 28412 (910) 341–7807 SD 1-05




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DATE: 6/28/21

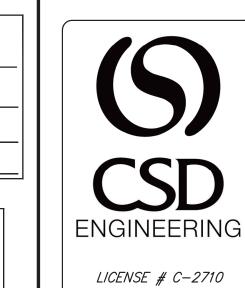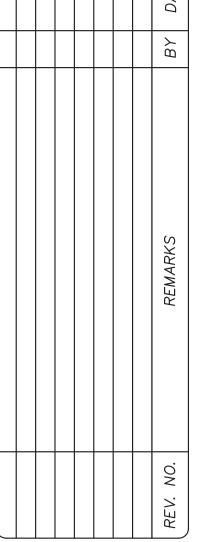HORZ. SCALE: N/A VERT. SCALE: N/A DRAWN BY: JSM

CHECKED BY: HSR PROJECT NO.: 21-0561